

DEPARTMENT OF REGULATORY AND ECONOMIC RESOURCES (RER) BOARD AND CODE ADMINISTRATION DIVISION

MIAMI-DADE COUNTY
PRODUCT CONTROL SECTION
11805 SW 26 Street, Room 208
T (786) 315-2590 F (786) 315-2599

www.miamidade.gov/economy

# NOTICE OF ACCEPTANCE (NOA)

Tischler und Sohn (USA) Ltd. Six Suburban Avenue Stamford, CT 06901

Scope:

This NOA is being issued under the applicable rules and regulations governing the use of construction materials. The documentation submitted has been reviewed and accepted by Miami-Dade County RER-Product Control Section to be used in Miami-Dade County and other areas where allowed by the Authority Having Jurisdiction (AHJ).

This NOA shall not be valid after the expiration date stated below. The Miami-Dade County Product Control Section (In Miami-Dade County) and/ or the AHJ (in areas other than Miami-Dade County) reserve the right to have this product or material tested for quality assurance purposes. If this product or material fails to perform in the accepted manner, the manufacturer will incur the expense of such testing and the AHJ may immediately revoke, modify, or suspend the use of such product or material within their jurisdiction. RER reserves the right to revoke this acceptance, if it is determined by Miami-Dade County Product Control Section that this product or material fails to meet the requirements of the applicable building code.

This product is approved as described herein, and has been designed to comply with the Florida Building Code, including the High Velocity Hurricane Zone.

DESCRIPTION: Series "Mahogany Impact" Outswing Wood Casement Window - L.M.I.

APPROVAL DOCUMENT: Drawing No. 1530, titled "Out-Swing Impact Wood Casement Window", sheets 01 through 10 of 10, dated 04/03/08, with revision "B", dated 09/04/13, prepared by W. W. Schaefer Engineering & Consulting, P. A., signed and sealed by Warren W. Schaefer, P. E., bearing the Miami-Dade County Product Control Revision stamp with the Notice of Acceptance number and Expiration date by the Miami-Dade County Product Control Section.

## MISSILE IMPACT RATING: Large and Small Missile Impact Resistant

LABELING: Each unit shall bear a permanent label with the manufacturer's name or logo, Wedel (Schleswig-Holstein), Germany, series, and following statement: "Miami-Dade County Product Control Approved", unless otherwise noted herein.

RENEWAL of this NOA shall be considered after a renewal application has been filed and there has been no change in the applicable building code negatively affecting the performance of this product.

**TERMINATION** of this NOA will occur after the expiration date or if there has been a revision or change in the materials, use, and/or manufacture of the product or process. Misuse of this NOA as an endorsement of any product, for sales, advertising or any other purposes shall automatically terminate this NOA. Failure to comply with any section of this NOA shall be cause for termination and removal of NOA.

**ADVERTISEMENT:** The NOA number preceded by the words Miami-Dade County, Florida, and followed by the expiration date may be displayed in advertising literature. If any portion of the NOA is displayed, then it shall be done in its entirety.

**INSPECTION:** A copy of this entire NOA shall be provided to the user by the manufacturer or its distributors and shall be available for inspection at the job site at the request of the Building Official.

This NOA revises NOA No. 13-1105.08 and consists of this page 1 and evidence pages E-1 and E-2, as well as approval document mentioned above.

The submitted documentation was reviewed by Jaime D. Gascon, P. E.



J- 648000

NOA No. 14-0428.22 Expiration Date: January 08, 2019 Approval Date: July 10, 2014

Page 1

# NOTICE OF ACCEPTANCE: EVIDENCE SUBMITTED

#### A. DRAWINGS

- 1. Manufacturer's die drawings and sections. (Submitted under previous NOA No. 08–0804.14)
- Drawing No. 1530, titled "Out-Swing Impact Wood Casement Window", sheets 01 through 10 of 10, dated 04/03/08, with revision "B1", dated 09/04/13, prepared by W. W. Schaefer Engineering & Consulting, P. A., signed and sealed by Warren W. Schaefer, P. E. (Submitted under previous NOA No. 13-1105.08)

#### B. TESTS

- 1. Test reports on: 1) Air Infiltration Test, per FBC, TAS 202–94
  - 2) Uniform Static Air Pressure Test, Loading per FBC TAS 202-94
  - 3) Water Resistance Test, per FBC, TAS 202-94
  - 4) Large Missile Impact Test per FBC, TAS 201-94
  - 5) Cyclic Wind Pressure Loading per FBC, TAS 203-94
  - 6) Forced Entry Test, per FBC 2411 3.2.1, TAS 202-94

along with marked-up drawings and installation diagram of fixed and operable wood casement windows, prepared by Architectural Testing, Inc., Test Report No. ATI-77324.01-109-18, dated 06/30/08, signed and sealed by Michael D. Stremmel, P. E. (Submitted under NOA No. 08-0804.14)

#### C. CALCULATIONS

- 1. Anchor verification calculations and structural analysis, complying with FBC-2004 and 2007, prepared by W.W. Schafer Engineering & Consulting, P. A., dated 07/24/08, and updated to FBC-2010 on 10/28/13, signed and sealed by Warren W. Schafer, P. E. (Submitted under previous NOA No. 13-1105.08)
- 2. Glazing complies with ASTM E1300-04/09

#### D. QUALITY ASSURANCE

1. Miami-Dade Department of Regulatory and Economic Resources (RER)

#### E. MATERIAL CERTIFICATIONS

- 1. Notice of Acceptance No. 12–1231.10 issued to Eastman Chemical Company (MA) for their "Saflex Clear and Color Glass Interlayers" dated 03/28/13, expiring on 05/21/16.
- 2. Notice of Acceptance No. 12–1231.08 issued to Eastman Chemical Company (MA) for their "Saflex CP Saflex and Saflex HP Composite Glass Interlayers with PET Core" dated 03/28/13, expiring on 12/11/18.

Jaime D. Gascon, P. E.

Product Control Section Supervisor

NOA No. 14-0428.22

Expiration Date: January 08, 2019 Approval Date: July 10, 2014

## Tischler und Sohn (USA) Ltd.

## NOTICE OF ACCEPTANCE: EVIDENCE SUBMITTED

#### F. STATEMENTS

- 1. Statement letter of conformance, and compliance with FBC 5<sup>th</sup> Edition (2014), issued by W. W. Schaefer Engineering & Consulting, P.A., dated 05/15/14, signed and sealed by Warren W. Schaefer, P. E.
- 2. Statement letter of conformance, and compliance with FBC-2010, issued by W. W. Schaefer Engineering & Consulting, P.A., dated 09/03/13, signed and sealed by Warren W. Schaefer, P. E. (Submitted under previous NOA No. 13-1105.08)
- 3. Statement letter of independence and no financial interest, issued by W. W. Schaefer Engineering & Consulting, P.A., dated 09/04/13, signed and sealed by Warren W. Schaefer, P. E.
  - (Submitted under previous NOA No. 13-1105.08)
- 4. Distributor Agreement between Tischler und Sohn (USA), Ltd., Connecticut, USA, and Tischler/ Cornelius Korn, G.m.b.H., Wedel (Schleswig-Holstein), Germany, dated 04/13/09, signed by Tim Carpenter and Wilhelm Korn, respectively. (Submitted under previous NOA No. 11–1101.10)
- 5. Laboratory addendum letter for Test Report No. ATI-77324.01-109-18, issued by Architectural Testing, Inc., dated 11/20/08, signed and sealed by Michael D. Stremmel, P. E.
- 6. (Submitted under NOA No. 08-0804.14)
- 7. Laboratory compliance letter for Test Report No. ATI-77324.01-109-18, issued by Architectural Testing, Inc., dated 07/01/08, signed and sealed by Michael D. Stremmel, P. E.

(Submitted under NOA No. 08-0804.14)

#### G. OTHERS


1. Notice of Acceptance No. 13-1105.08, issued to Tischler und Sohn (USA), Ltd. for their Series "Mahogany Impact Wood Outswing Casement Window – L.M.I.", approved on 12/26/13 and expiring on 01/08/19.


Jaime D. Gascon, P. E.


Product Control Section Supervisor


NOA No. 14-0428.22

Expiration Date: January 08, 2019 Approval Date: July 10, 2014

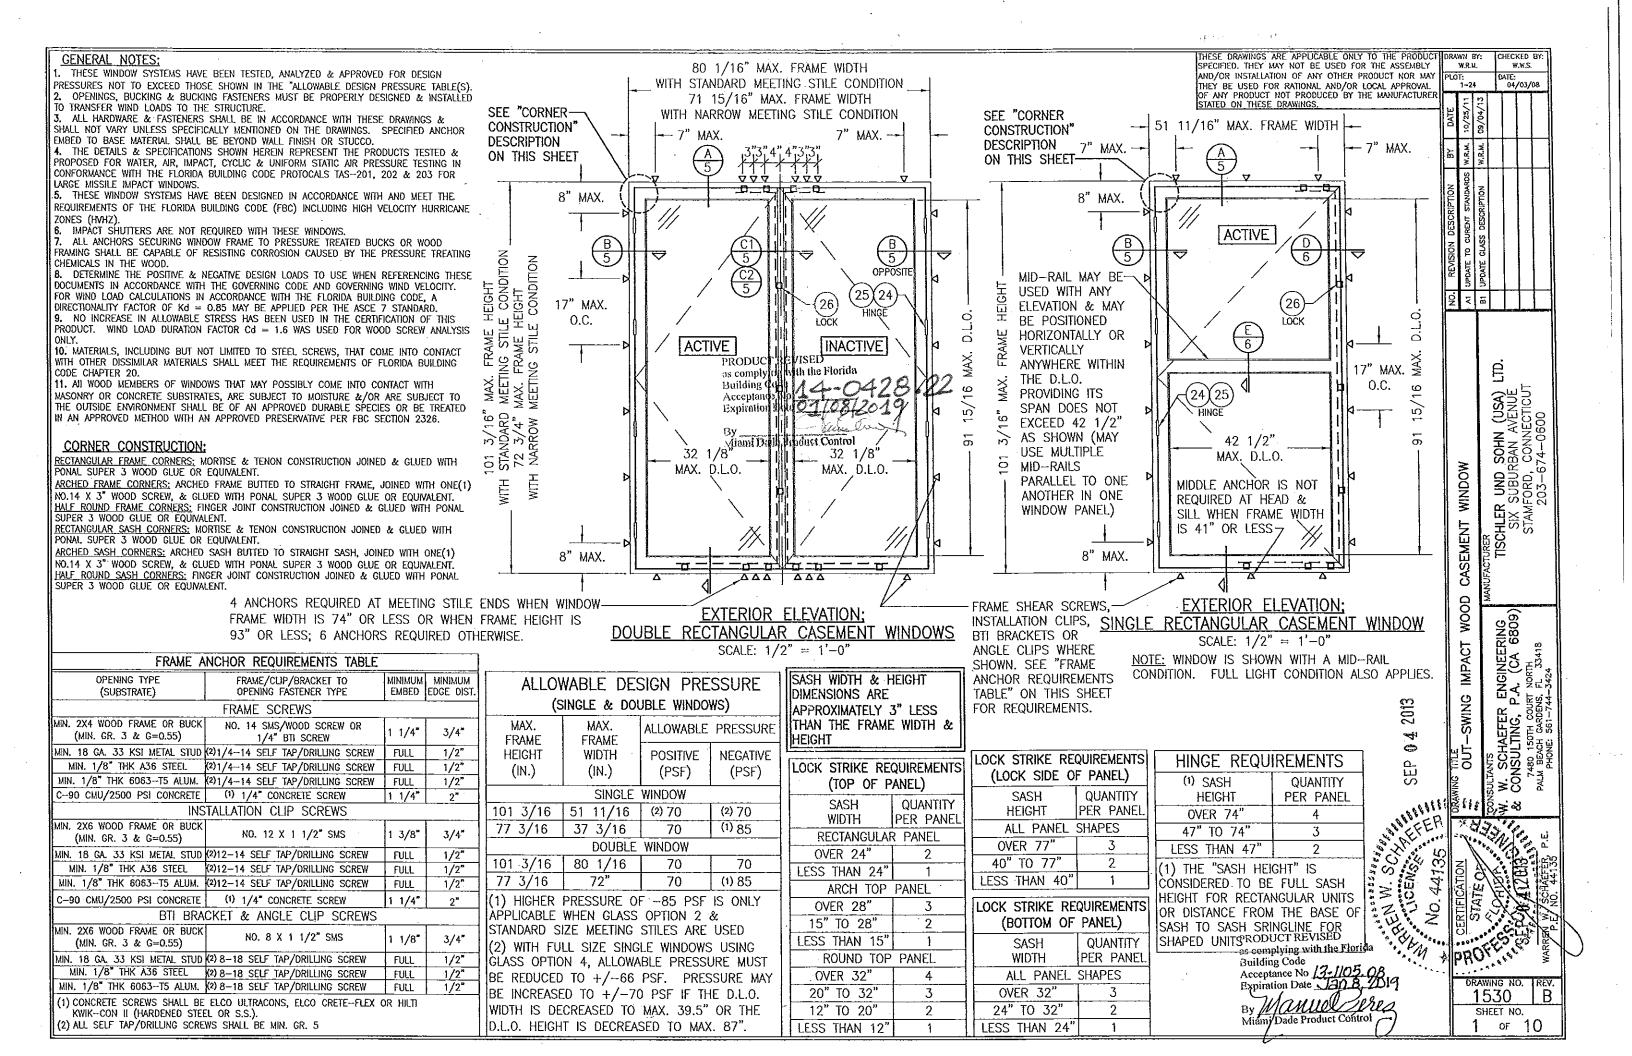

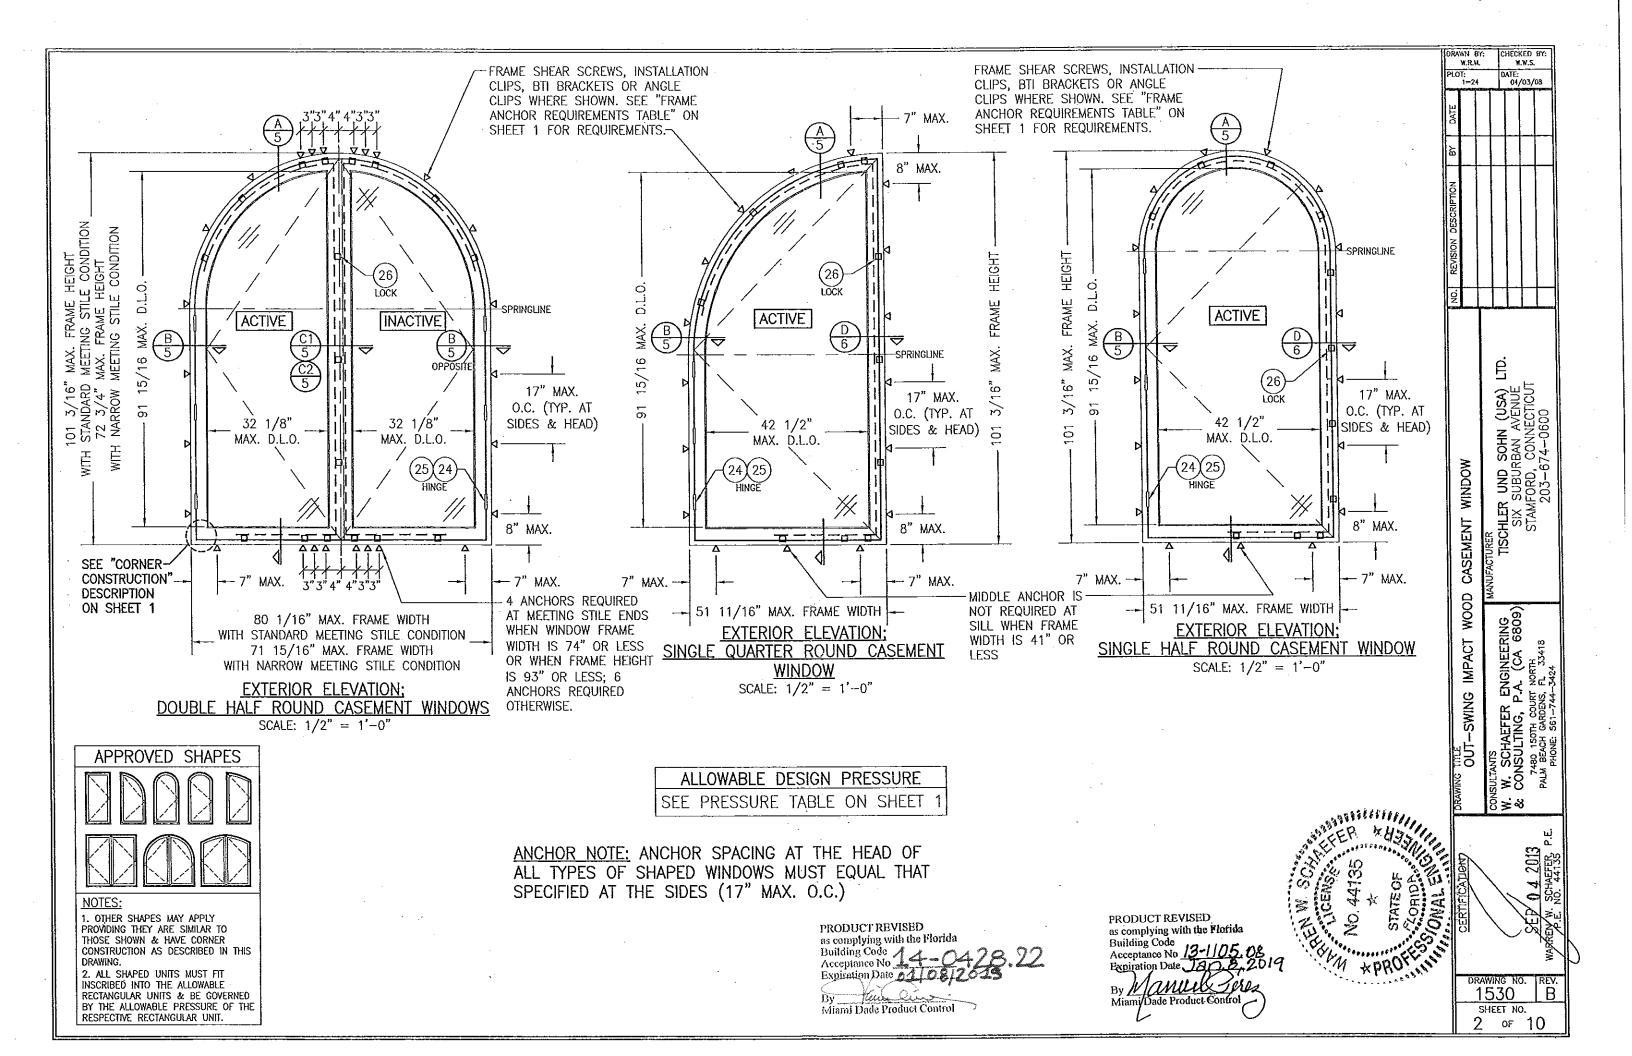

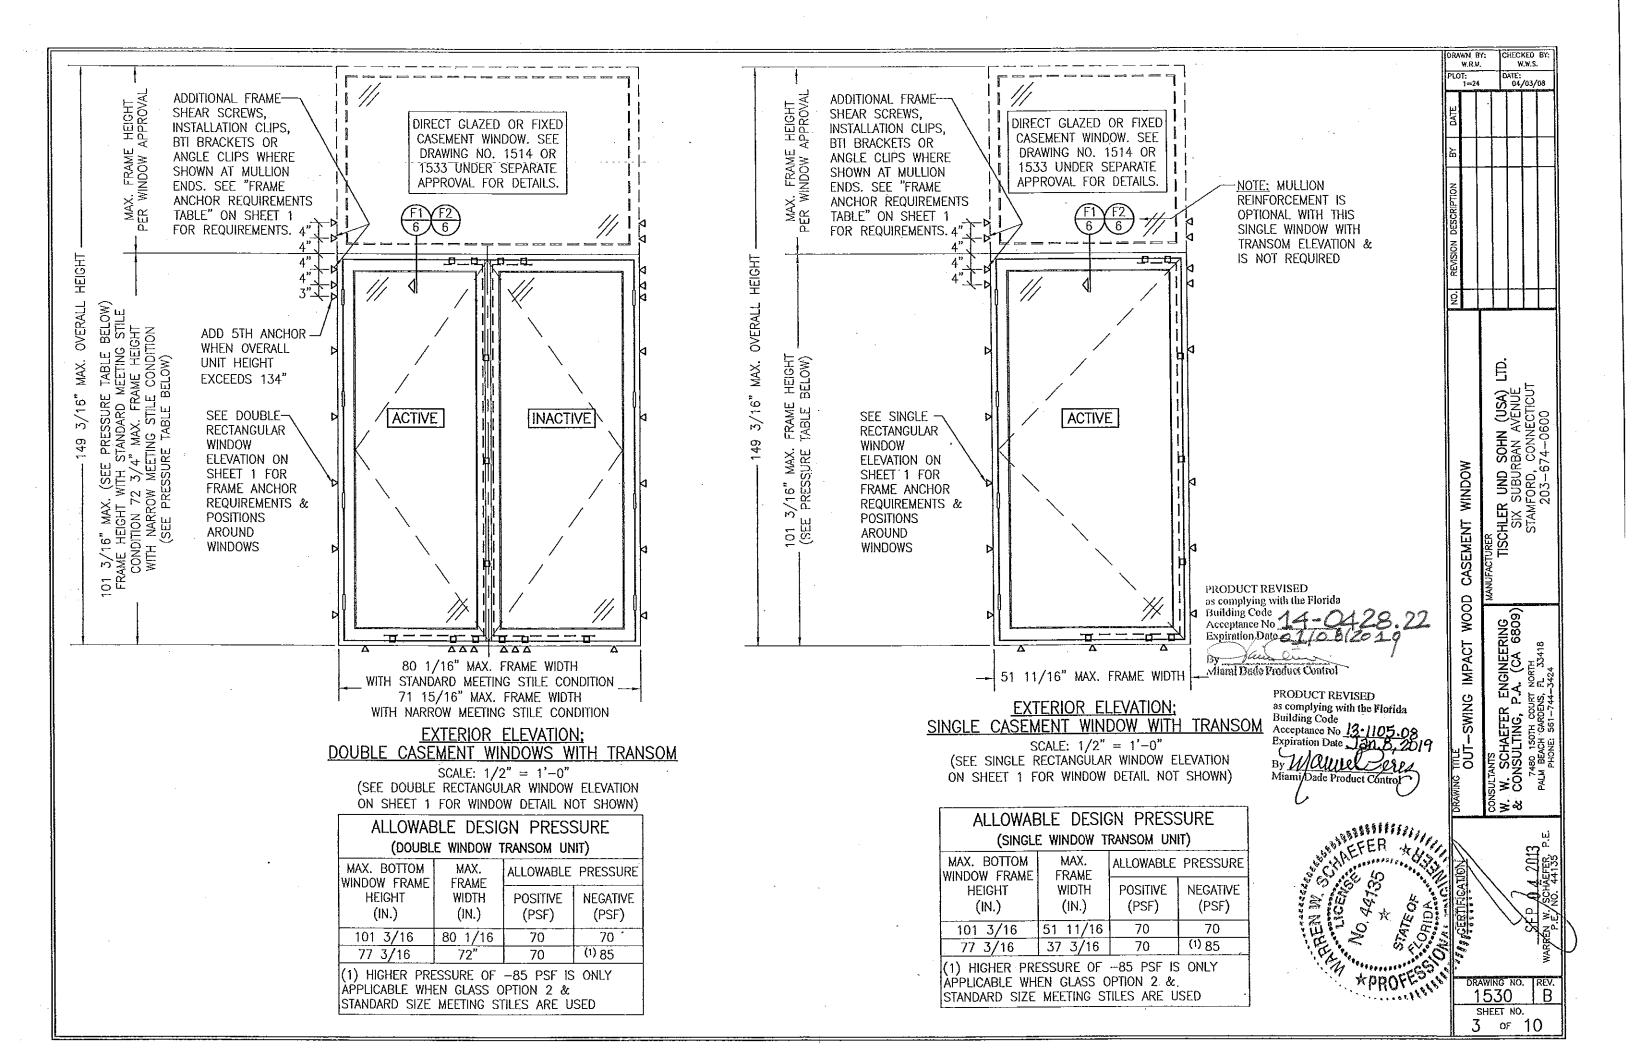

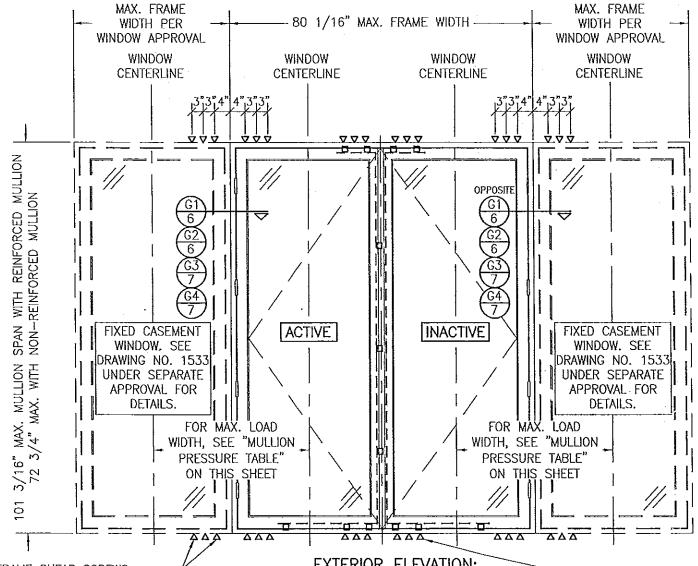

ADDITIONAL FRAME SHEAR SCREWS,-INSTALLATION CLIPS, BTI BRACKETS OR ANGLE CLIPS WHERE SHOWN AT MULLION ENDS. SEE "FRAME ANCHOR REQUIREMENTS TABLE" ON SHEET 1 FOR REQUIREMENTS. (SEE MULLION PRESSURE TABLE FOR REQUIRED QUANTITY OF ANCHORS AT MULLION ENDS)

**EXTERIOR ELEVATION;** MULTIPLE CASEMENT/FIXED WINDOWS

SCALE: 1/2" = 1'-0"

SEE INDIVIDUAL WINDOW ELEVATIONS FOR FRAME ANCHOR REQUIREMENTS & POSITIONS AROUND WINDOWS

OXXO UNIT IS SHOWN. ALL OTHER FIXED/OPERABLE COMBINATIONS ALSO APPLY WITH THE MULLION CONDITIONS SHOWN.

# **MULTIPLE UNIT NOTES:**

- FOR ALL DETAIL NOT SHOWN, INDIVIDUAL WINDOW ELEVATIONS.
- THERE IS NO LIMIT ON THE NUMBER OF WINDOWS THAT MAY BE COMBINED IN ONE DIRECTION INTO ONE OPENING PROVIDING THE OPENING IS DESIGNED TO SUPPORT ALL LOADS TRANSFERED FROM THE WINDOWS & THEIR MULLIONS.
- 3. ANY COMBINATION OF FIXED/OPERABLE WINDOWS IN ONE OPENING SHALL APPLY.
- SHAPED WINDOWS ALSO APPLY TO SIDE MULLING (WHEN APPLICABLE) UNDER THE SAME RESTRICTIONS SHOWN.
- 5. MULLIONS MAY BE A 1-PIECE SECTION OR JAMB TO JAMB. SEE SECTIONS G1 THROUGH G4 FOR DETAIL.

PRODUCT REVISED as complying with the Florida Acceptance No Expiration Date 21

Miaml Dade Product Control

101	70	N/A	13/73	30.2	JU.Z		_00.1	œ	t I
	37	N/A	N/A	65.3	65.3	70.0	75.2	REVISION DESCR	
	31	N/A	N/A	70.0	78.0	70.0	85.0		
	25	N/A	N/A	70.0	85.0	70.0	85.0	VISIC	
96	52	N/A	N/A	48.9	48.9	56.7	56.7	Æ	
	49	N/A	N/A	51.9	51.9	60.1	60.1	Š	++
	43	N/A	N/A	59.2	59.2	68.5	68.5	<u>-</u>	╁┸
	37	N/A	N/A	68.8	68.8	70.0	79.6		1
	31	N/A	N/A	70.0	82.1	70.0	85.0		
	25	N/A	N/A	70.0	85.0	70.0	85.0		
84	52	N/A	N/A	55.9	55.9	64.7	64.7		
	49	N/A	N/A	59.3	59.3	68.7	68.7		1 3
	43	N/A	N/A	67.6	67.6	70.0	78.3		(ASI)
	37	N/A	N/A	70.0	78.6	70.0	85.0		NHOS
	31	N/A	N/A	70.0	85.0	70.0	85.0		ļģ
77	52	N/A	N/A	61.0	61.0	70.0	70.6	WINDOW	٦
	49	N/A	N/A	64.7	64.7	70.0	75.0		CN
	43	N/A	N/A	70.0	73.8	70.0	85.0		ρ
	37	N/A	N/A	70.0	85.0	70.0	85.0	<u> </u>	URER TISCHI FR
72 3/4	52	54.7	54.7	64.6	64.6	70.0	74.8	巨	E C
	49	56.7	56.7	68.5	68.5	70.0	79.3	CASEMENT	
	43	62.0	62.0	70.0	78.1	70.0	85.0		UFA(
	37	70.0	70.0	70.0	85.0	70.0	85.0		MANUFACTURER TISC
	31	70.0	80.7	70.0	85.0	70.0	85.0	ļ ģ	
	25	70.0	85.0	70.0	85.0	70.0	85.0	WOOD	۲
67	52	66.9	66.9	70.0	70.1	70.0	81.2	5	<u> </u>
	49	69.0	69.0	70.0	74.4	70.0	85.0	∥ĕ	
	43	70,0	74.9	70.0	84.8	70.0	85.0	SWING IMPACT	CNIGHENIONE
	37	70.0	83.7	70.0	85.0	70.0	85.0	∐ ს	
	31	70.0	85.0	70.0	85.0	70.0	85.0	∥₹	NATS
61	52	70.0	77.0	70.0	77.0	70.0	85.0	اً اِنْ	
	49	70.0	81.7	70.0	81.7	70.0	85.0°	15	ز <sub>د</sub>
	43	70.0	85.0	70.0		70.0	85.0	-li	Įξί
55	52	70.0	85.0	70.0	85.0	70.0	85.0	18	Z Z
NOTES:				_				DRAWING	CONSULTANTS
1. LOAD \	WIDTH IS TH	ie distan	CE BETW	een wi	NDOW			. 26	1 45

MULLION ALLOWABLE DESIGN PRESSURE

NON-REINFORCED

4 OR 6 END

**ANCHORS** 

NEG.

N/A

N/A

N/A

POS.

N/A

N/A

N/A

ALLOWABLE PRESSURE (+/- PSF)

4 END

ANCHORS

POS. NEG.

56.2 | 56.2 |

REINFORCED

46.5 | 46.5 | 53.8 | 53.8

49.3 49.3 57.1

6 END

**ANCHORS** 

POS. NEG.

65.1 65.1

57.1

MAXIMUM

LOAD

WIDTH

(IN.)

52

49

43

MAXIMUM MULLION

SPAN

(IN.)

CENTERLINES.

CENTERLINES.

2. ALLOWABLE UNIT PRESSURE SHALL BE THE LESSER OF THE CONTROL OF TH PRESSURES SHOWN IN THIS TABLE & THOSE SPECIFIED FOR THE INDIVIDUAL WINDOW.

3. "N/A" DESIGNATES A SIZE NOT APPLICABLE TO THAT REINFORCEMENT CONDITION.

4. SIZE VALUES IN TABLE ARE +/-1/2"


PRODUCT REVISED as complying with the Florida


1530 SHEET NO.


LOT: 1=24


XTE<del>:</del> 04/03/08


4 or 10

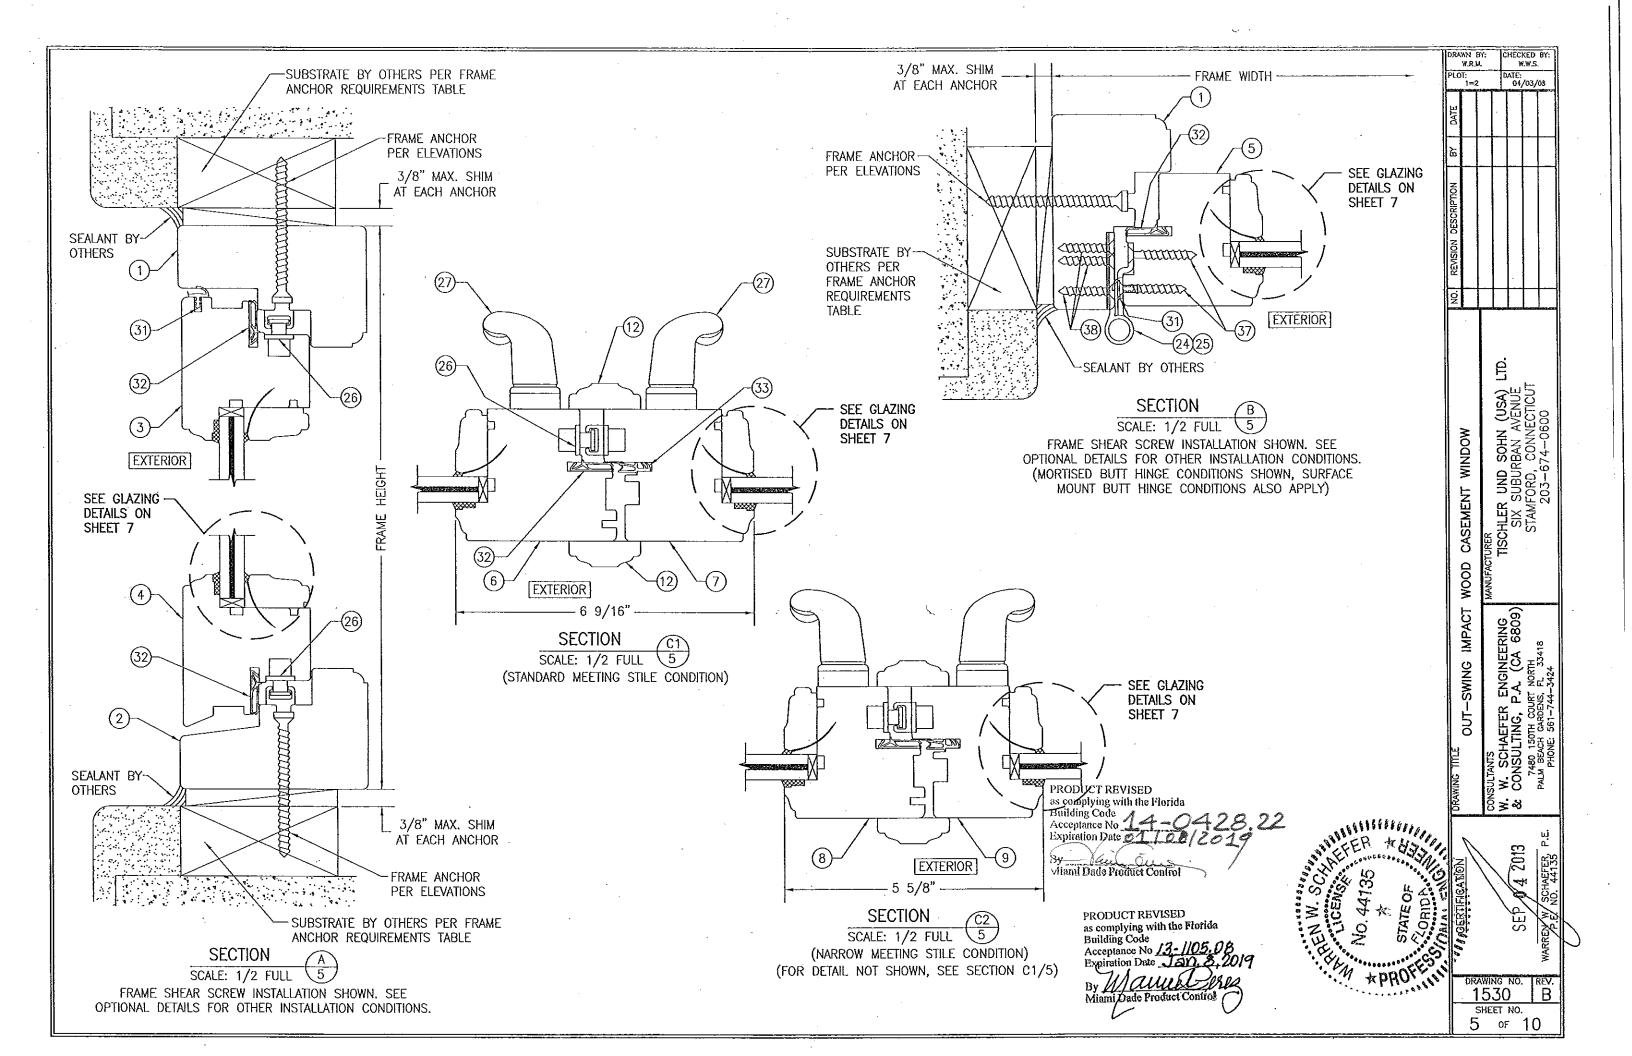

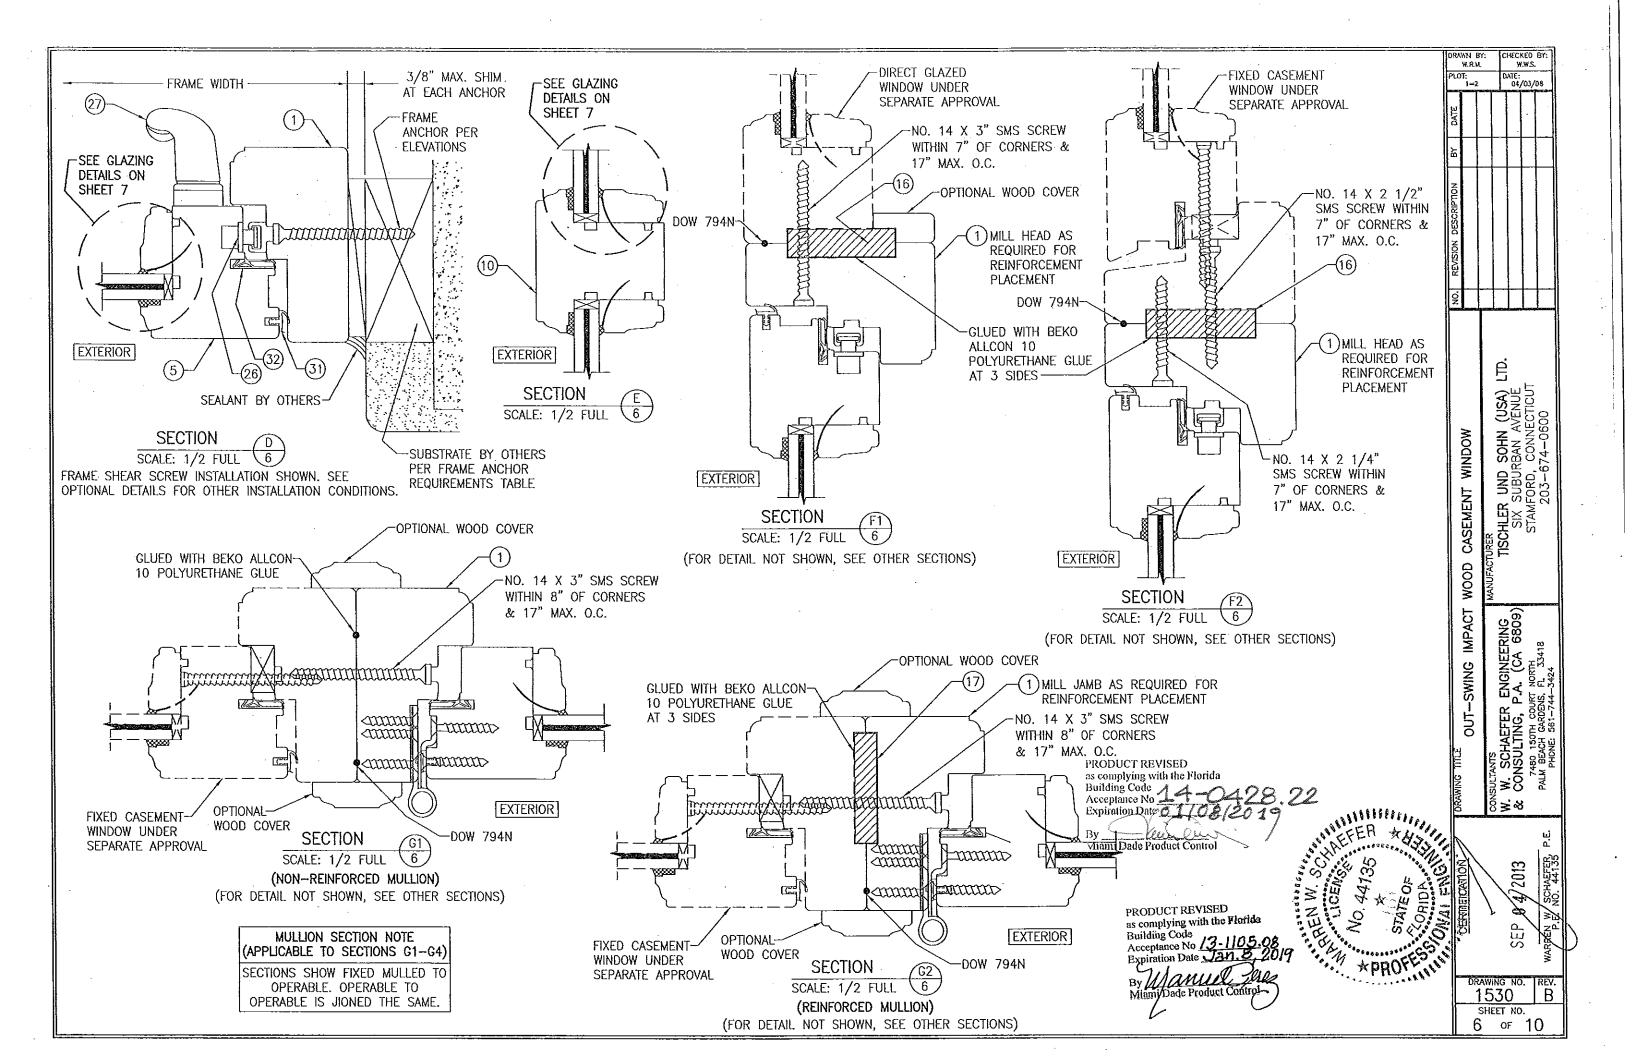

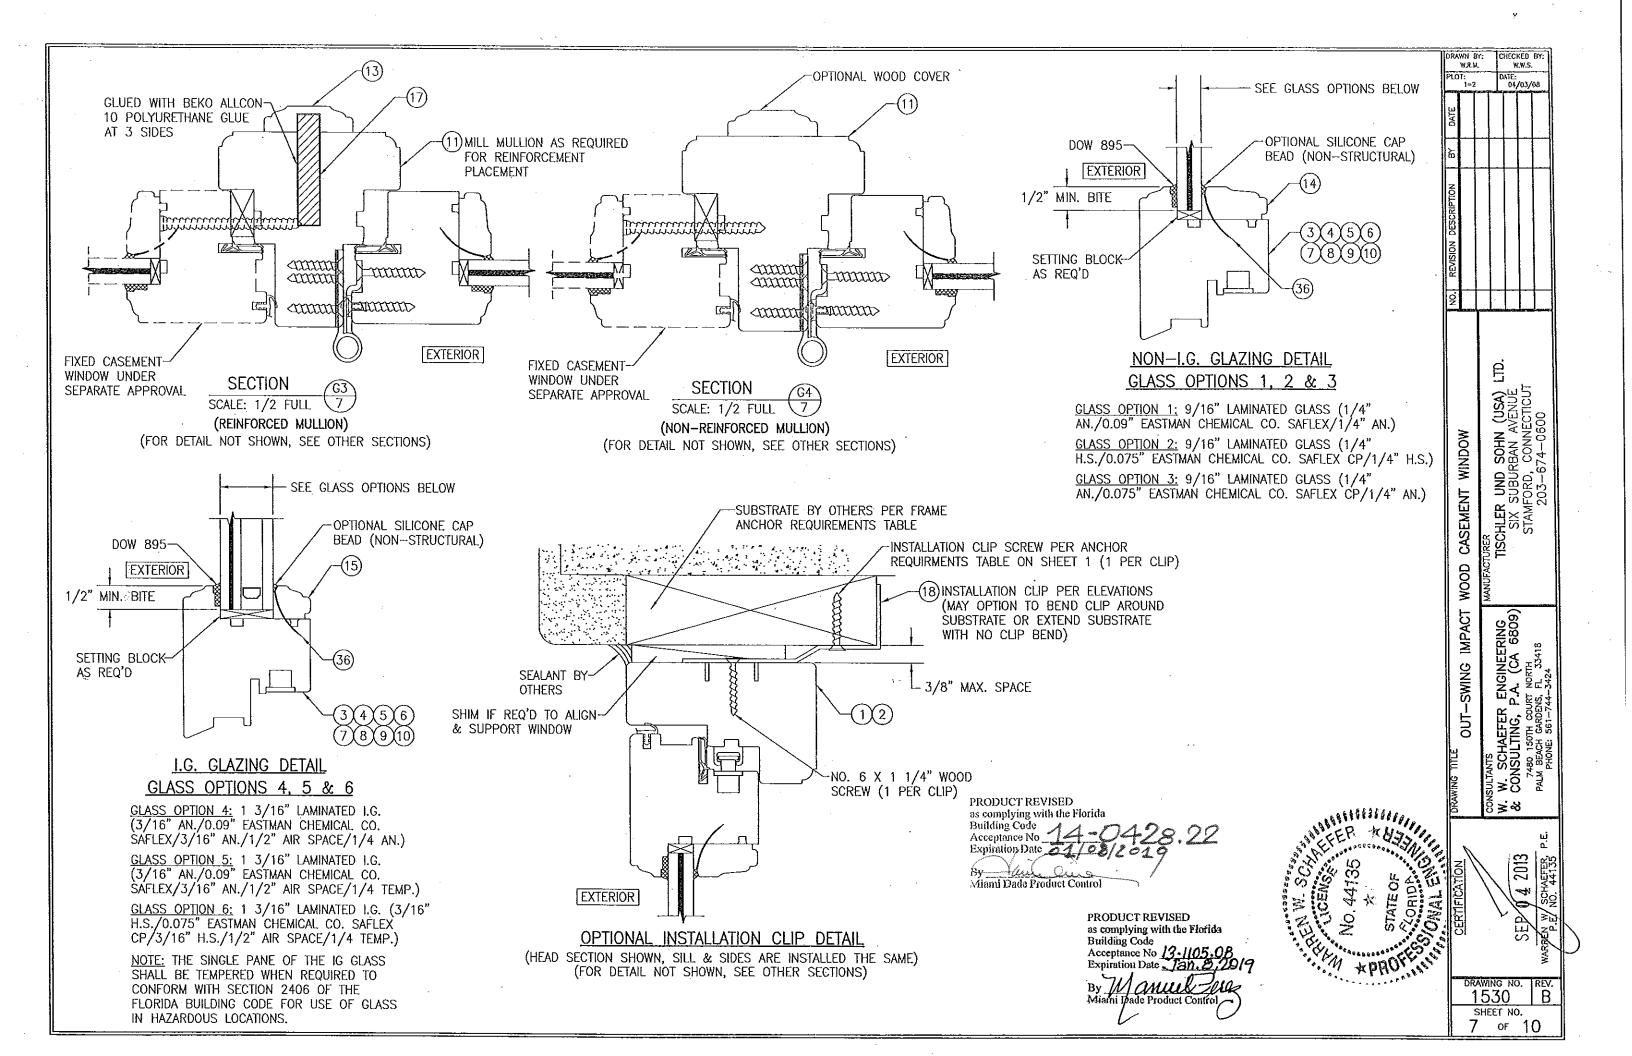

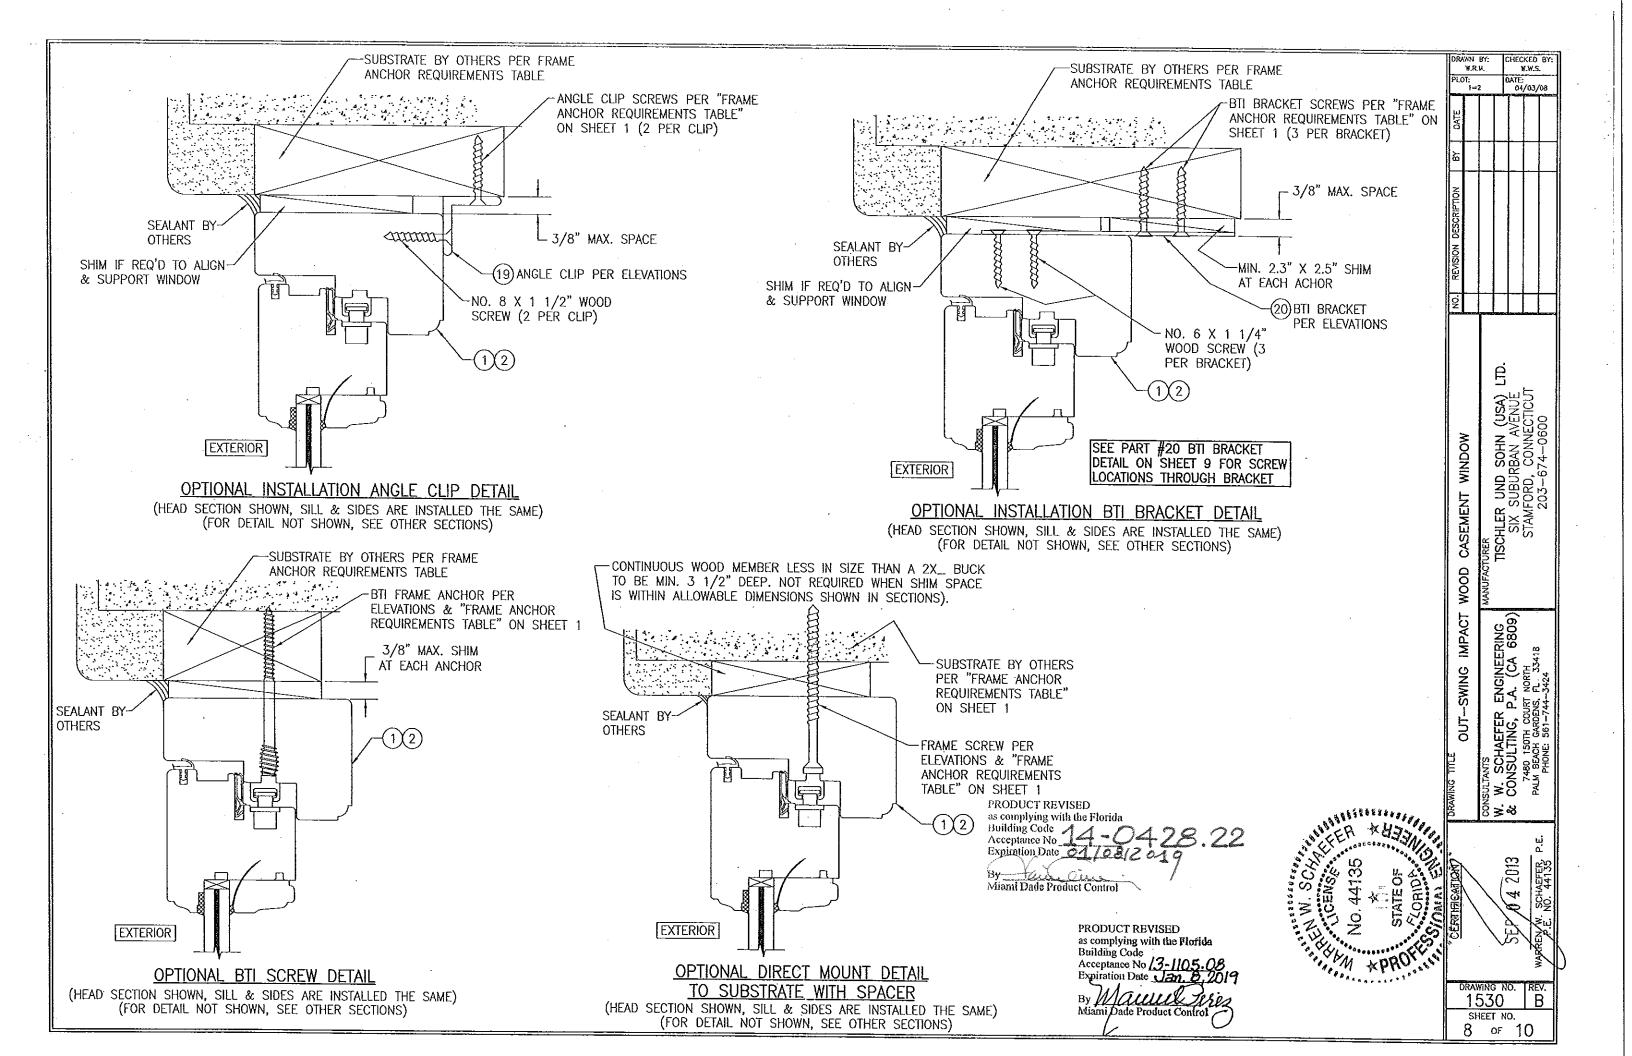

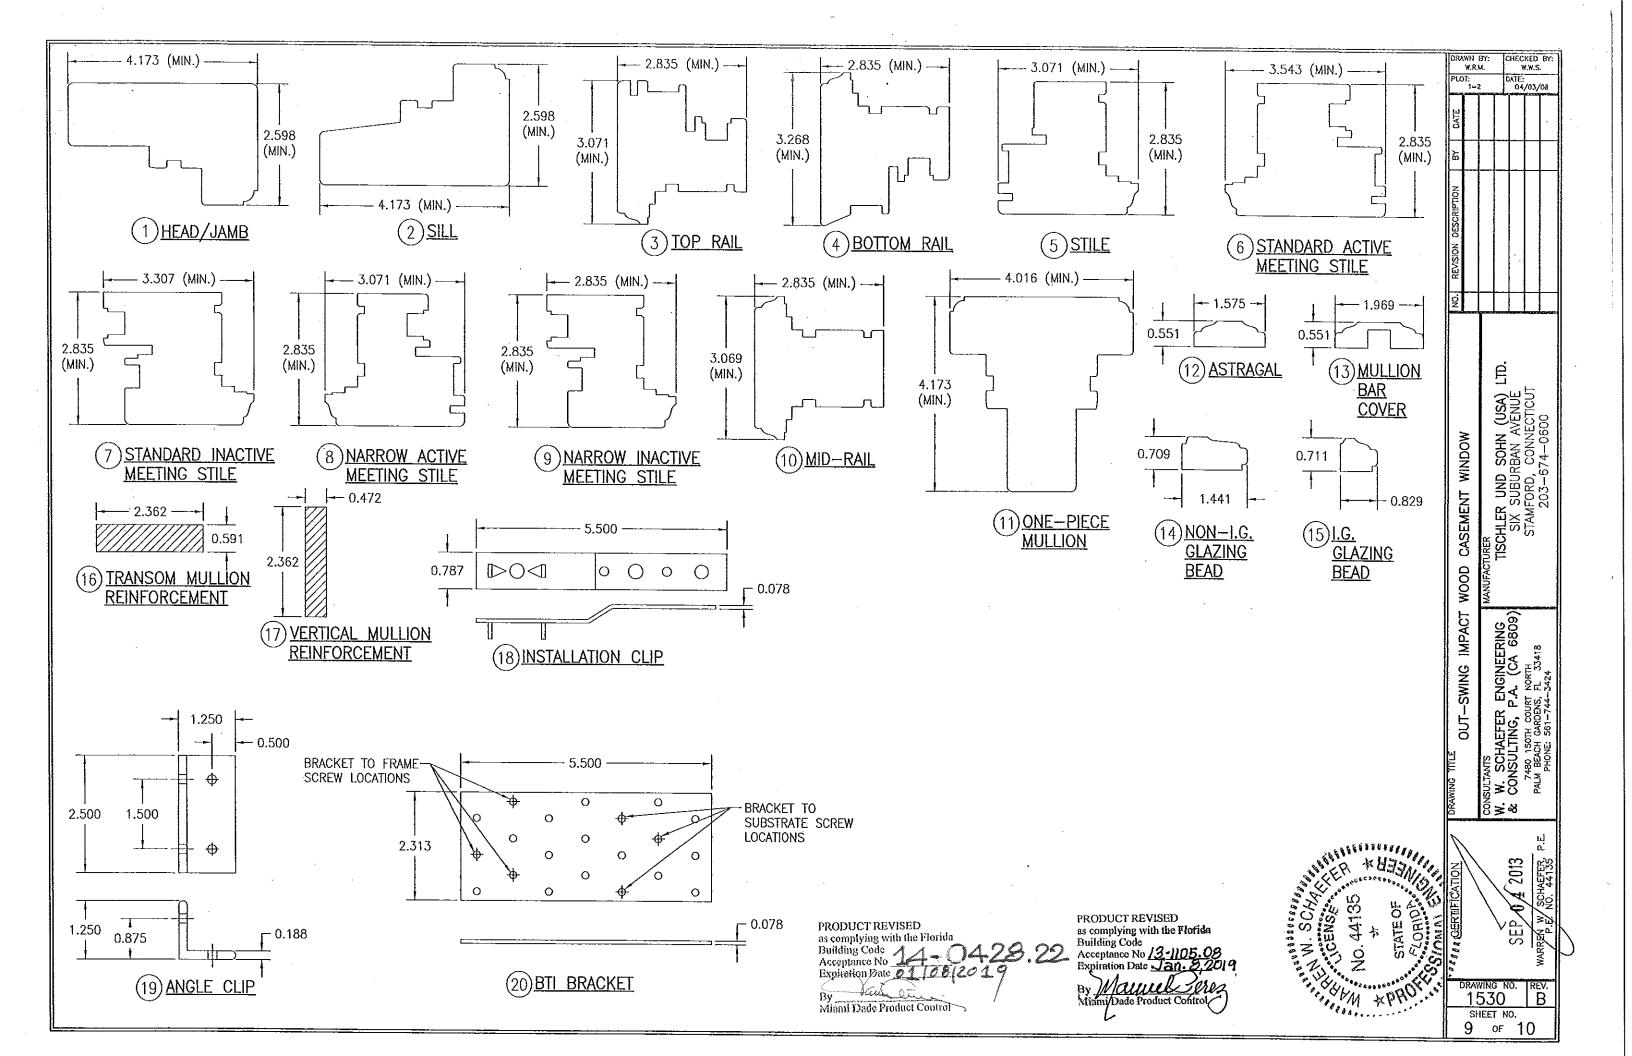

ІТЕМ #	ITEM DESCRIPTION	MANUFACTURER/NOTES					
PARTS							
1	HEAD/JAMB	MAHOGANY					
2	SILL	MAHOGANY					
. 3	TOP RAIL	MAHOGANY					
4	BOTTOM RAIL	MAHOGANY					
5	STILE	MAHOGANY					
6	STANDARD ACTIVE MEETING STILE	MAHOGANY					
7	STANDARD INACTIVE MEETING STILE	MAHOGANY					
8	NARROW ACTIVE MEETING STILE	MAHOGANY					
9	NARROW ACTIVE MEETING STILE	MAHOGANY					
10	MID-RAIL.	MAHOGANY					
11	ONE-PIECE MULLION	MAHOGANY					
12	ASTRAGAL	MAHOGANY					
13	MULLION BAR COVER	MAHOGANY					
14	NON-I.G. GLAZING BEAD	MAHOGANY					
15	I.G. GLAZING BEAD	MAHOGANY					
16	TRANSOM MULLION REINFORCEMENT	34 KSI STAINLESS STEEL OR A36 STEEL					
17	VERTICAL MULLION REINFORCEMENT	34 KSI STAINLESS STEEL OR A36 STEEL					
18	INSTALLATION CLIP	GALVANIZED 54 KSI STEEL					
19	ANGLE CLIP	6061-T6 ALUMINUM					
20	BTI BRACKET	GALVANIZED 54 KSI STEEL					
HARDWARE							
24	BUTT HINGE 2 7/8" LONG	BY: GENIATE GMBH					
25	BUTT HINGE 4 3/4" LONG	BY: GENIATE GMBH					
26	MULTI-POINT LOCK SYSTEM	BY: SIEGENIA AUBI KG TYPE: MUSHROOM					
27	HANDLE	AS REQUIRED TO OPERATE LOCK SYSTEM					
SEALS & SEALANTS							
31	WEATHERSTRIP	THERMOPLASTIC ELASTOMER; BY: DEVENTER					
32	WEATHERSTRIP	THERMOPLASTIC ELASTOMER; BY: DEVENTER					
33	WEATHERSTRIP	THERMOPLASTIC ELASTOMER; BY: DEVENTER					
<b> </b>	FASTENERS						
36	OPTIONAL 18 GA. X 1 1/2" S.S. CURVED NAIL	4" FROM CORNERS & 12" MAX. O.C.					
37	NO. 10 X 1 1/2" WOOD SCREW	2 PER HINGE INTO SASH					
38	NO. 10 X 1 1/4" WOOD SCREW	3 PER HINGE INTO JAMB					

NOTE: WOOD USED IN TESTING WAS SIPO MAHOGANY WITH A SPECIFIC GRAVITY OF G=0.62 AND A MODULUS OF ELASTICITY OF E=1,6000,000 PSI. OTHER WOOD SPECIES APPLICABLE FOR USE WITH THIS PRODUCT ARE THOSE WITH A SPECIFIC GRAVITY OF 0.62 AND MODULUS OF ELASTICITY OF 1,600,000 PSI OR GREATER. ALL WOOD IS MINIMUM GRADE 2 MILLED BY TISCHLER UND SOHN TO SELECT.

> PRODUCT REVISED as complying with the Florida
> Building Code

Miami Dade Product Control

PRODUCT REVISED
as complying with the Florida
Building Code
Acceptance No 13-1105.0
Expiration Date 1 an 5.70

OUT-SWING IMPACT WOOD CASEMENT WINDOW 04 2013

drawing no. 1530

SHEET NO. 10 or 10

CHECKED BY:

DRAWN BY: W.R.U. PLOT: 1=2